

1 SITE MAP

SCALE: NTS

Ground Mount PV System Summary

DC Size (MW)	2.431
AC Size (MW)	1.7
DC / AC Ratio	1.43
Number of Modules	4,420
Module Nominal Power Watt Pmax (W)	550
Racking Type / Tilt Angle	Fixed / 30°
Module Azimuth	0°
Fenced Area Footprint (acres)	12.5
Proposed POI GPS Coordinates	46.153418, -60.128615

NOTES:
1. THE PRELIMINARY SITE PLAN ISSUED FOR DISTRIBUTION SYSTEM IMPACT STUDY ONLY.
2. FINAL LAYOUT WITHIN FENCELINE SUBJECT TO CHANGE AT TENANT DISCRETION TO ALIGN WITH UTILITY, PERMITTING AND MANUFACTURER REQUIREMENTS.


0 200m

LEGEND:

- Existing Residential Home
- Existing Residence Cluster
- Existing Building

2 SITE PLAN

SCALE: 1.5"=200m @ 11" x 17" B-size

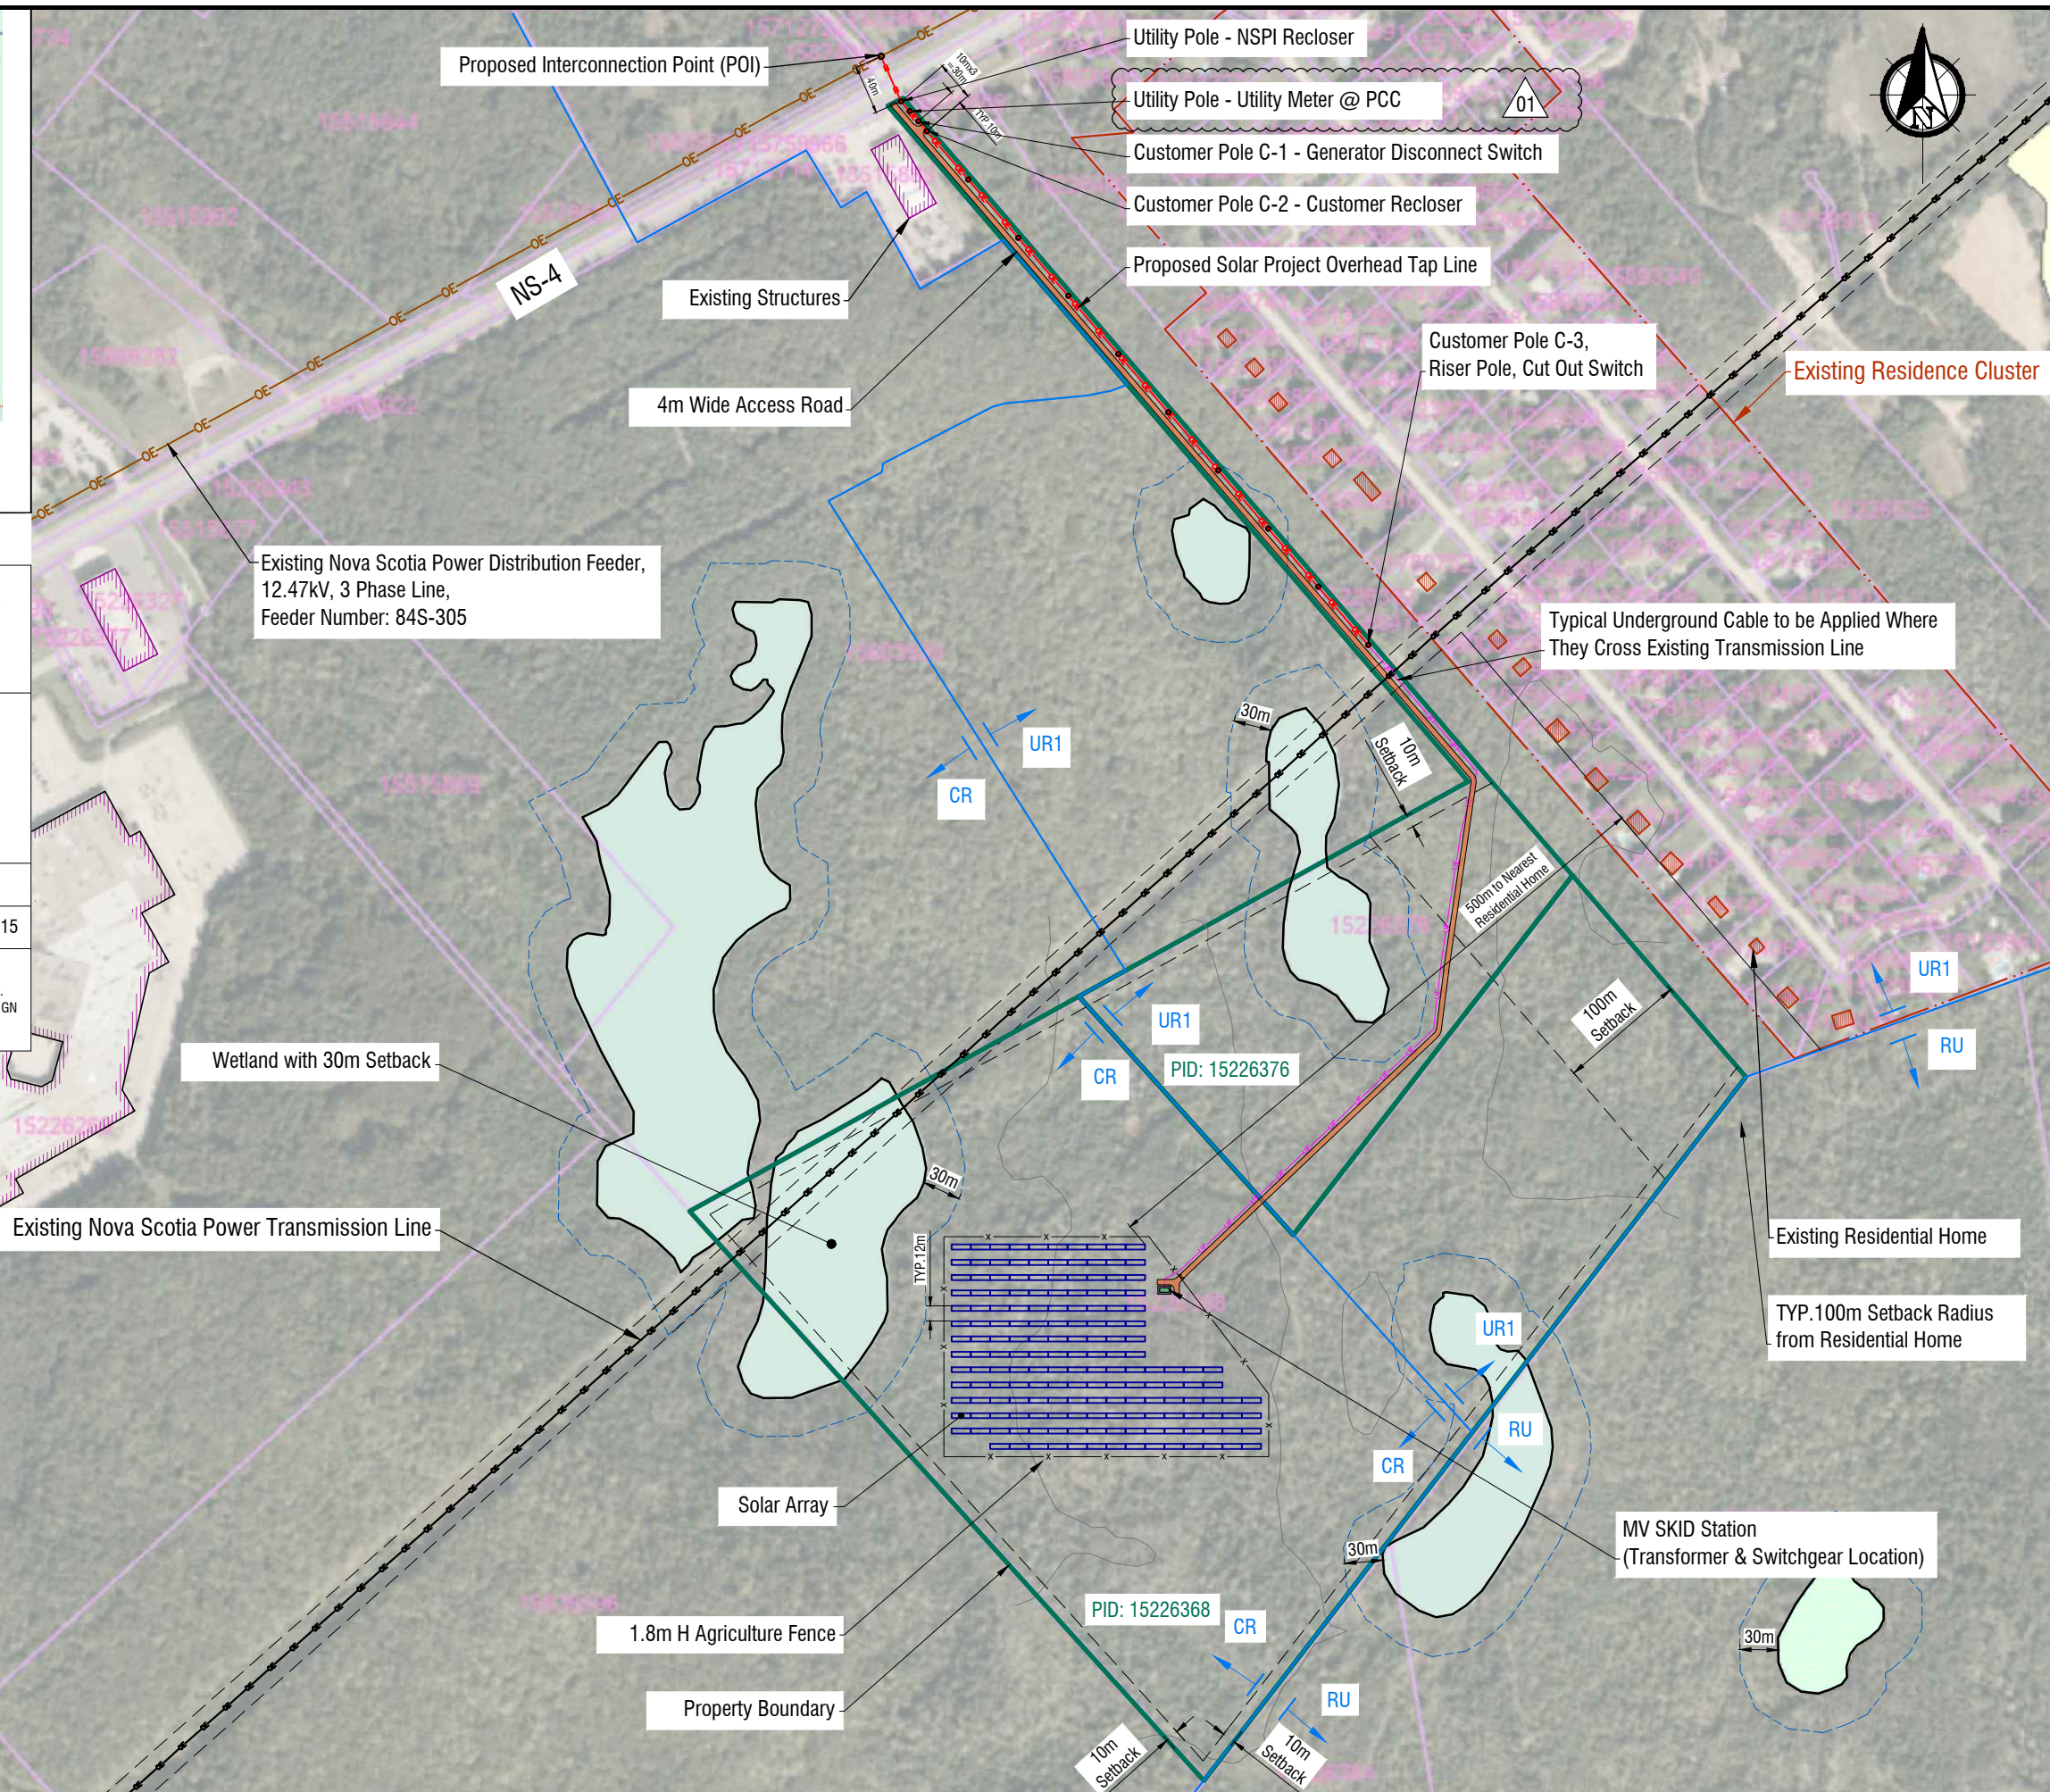

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ISSUE STAGE:
ISSUED FOR DSIS

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ENGINEER'S SEAL

REV#	DESCRIPTION	DATE	D.B.	C.B.
01	ISSUED FOR DSIS	2025/05/28	S.W.	S.X.
00	ISSUED FOR CSP	2024/09/10	S.W.	S.X.

DRAWING NAME:
SITE PLAN

DRAWN BY:
S.W.

SCALE:
AS SHOWN

PROJECT ADDRESS:
Grand Lake Rd, Sydney, NS B1M 1A7

CHECKED BY:
S.X.

DATE:
2025/05/28

PROJECT NAME:
NS - Grand Lake Rd Solar Farm

DRAWING NO:
C-101

REV. NO:
01